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project title:
Gardnerville Station

**1395 US 395 N
GARDNERVILLE, NV**

job number: 16-100
date: June 30, 2017
drawn by: amm
checked by: prd
revisions:
▲ 1.11.18 PLN RWV CMTS
▲ BIDDING 2.20.18
▲ BIDDING 2.26.18

sheet description:
**REFLECTED
CEILING PLAN**

sheet number:
A201

GENERAL NOTES:

- SEE GENERAL SHEETS FOR PROJECT NOTES, TYPICAL ACCESSIBILITY REQUIREMENTS AND TYPICAL SIGNAGE DETAILS
- BUILDING GRID LINES ARE SHOWN TO THE CENTERLINE OF EXISTING WALLS
- GENTLY CLEAN EXTERIOR OF BUILDING. PRESSURE WASH USING NO MORE THAN GARDEN HOSE PRESSURE AND A SIMPLE SOAP SOLUTION
- PREP SURFACES TO RECEIVE NEW PAINT PER SPECIFICATIONS. SEAL ALL HOLES, CRACKS AND PENETRATIONS WITH METAL, WOOD, CONCRETE, OR MASONRY BONDING FILLER AS REQUIRED FOR SUBSTRATE AND AS RECOMMENDED BY MANUFACTURER OF EACH PRODUCT. ALL WORK TO CONFORM TO CURRENT OSHA AND EPA STANDARDS FOR LEAD PAINT REMOVAL

CEILING GENERAL NOTES:


- CONTRACTOR TO FIELD VERIFY ALL DIMENSIONS PRIOR TO START OF WORK AND NOTIFY ARCHITECT IMMEDIATELY OF ANY CONCERNS OR DISCREPANCIES
- CONTRACTOR TO VERIFY CLEARANCES TO ENSURE OPERATION OF SECTIONAL OVERHEAD DOORS. COORDINATE LAYOUT OF NEW CEILING SUPPORT STRUCTURE WITH SUSPENDED ACOUSTIC PANELS, STRIP LIGHTING, AND HVAC DUCTING AND DIFFUSERS

KEY NOTES:

- OPEN TO STRUCTURE ABOVE. SEE FINISH SCHEDULE FOR NEW PAINT
- CAREFULLY SCARIFY EXISTING PAINT ON METAL WALL PANEL USING METAL WIRE WHEEL TO ACHIEVE DESIRED FINISH BASED ON MOCK-UP SAMPLE APPROVED BY ARCHITECT. THOROUGHLY CLEAN WALL AND APPLY CLEAR POLYURETHANE PROTECTIVE TOP COAT
- PROVIDE NEW CEILING, 5/8 INCH GYP.BD. OVER METAL FRAMING. TAPE, TEXTURE AND PAINT
- PAINT EXISTING METAL SOFFIT. SEE FINISH SCHEDULE FOR MORE INFORMATION
- APPLY NEW LAYER 5/8 INCH GYP.BD. OVER EXISTING METAL PANEL CEILING. COORDINATE INSTALLATION OF STRIP FIXTURES - S.E.D.
- PAINT EXISTING METAL PANEL CEILING. SEE FINISH SCHEDULE FOR MORE INFORMATION
- PROVIDE (N) 3/4" WTR SERVICE IP POLYETHYLENE TUBING CLASS 200 FROM FURRED OUT WALL TO ABOVE (N) BEAM STRUCTURE TO (N) RESTROOMS, SEE PLAN FOR ROUTING

LEGEND:

- DIFFUSER
- LIGHT FIXTURE
- SUPPLY REGISTER
- RETURN REGISTER

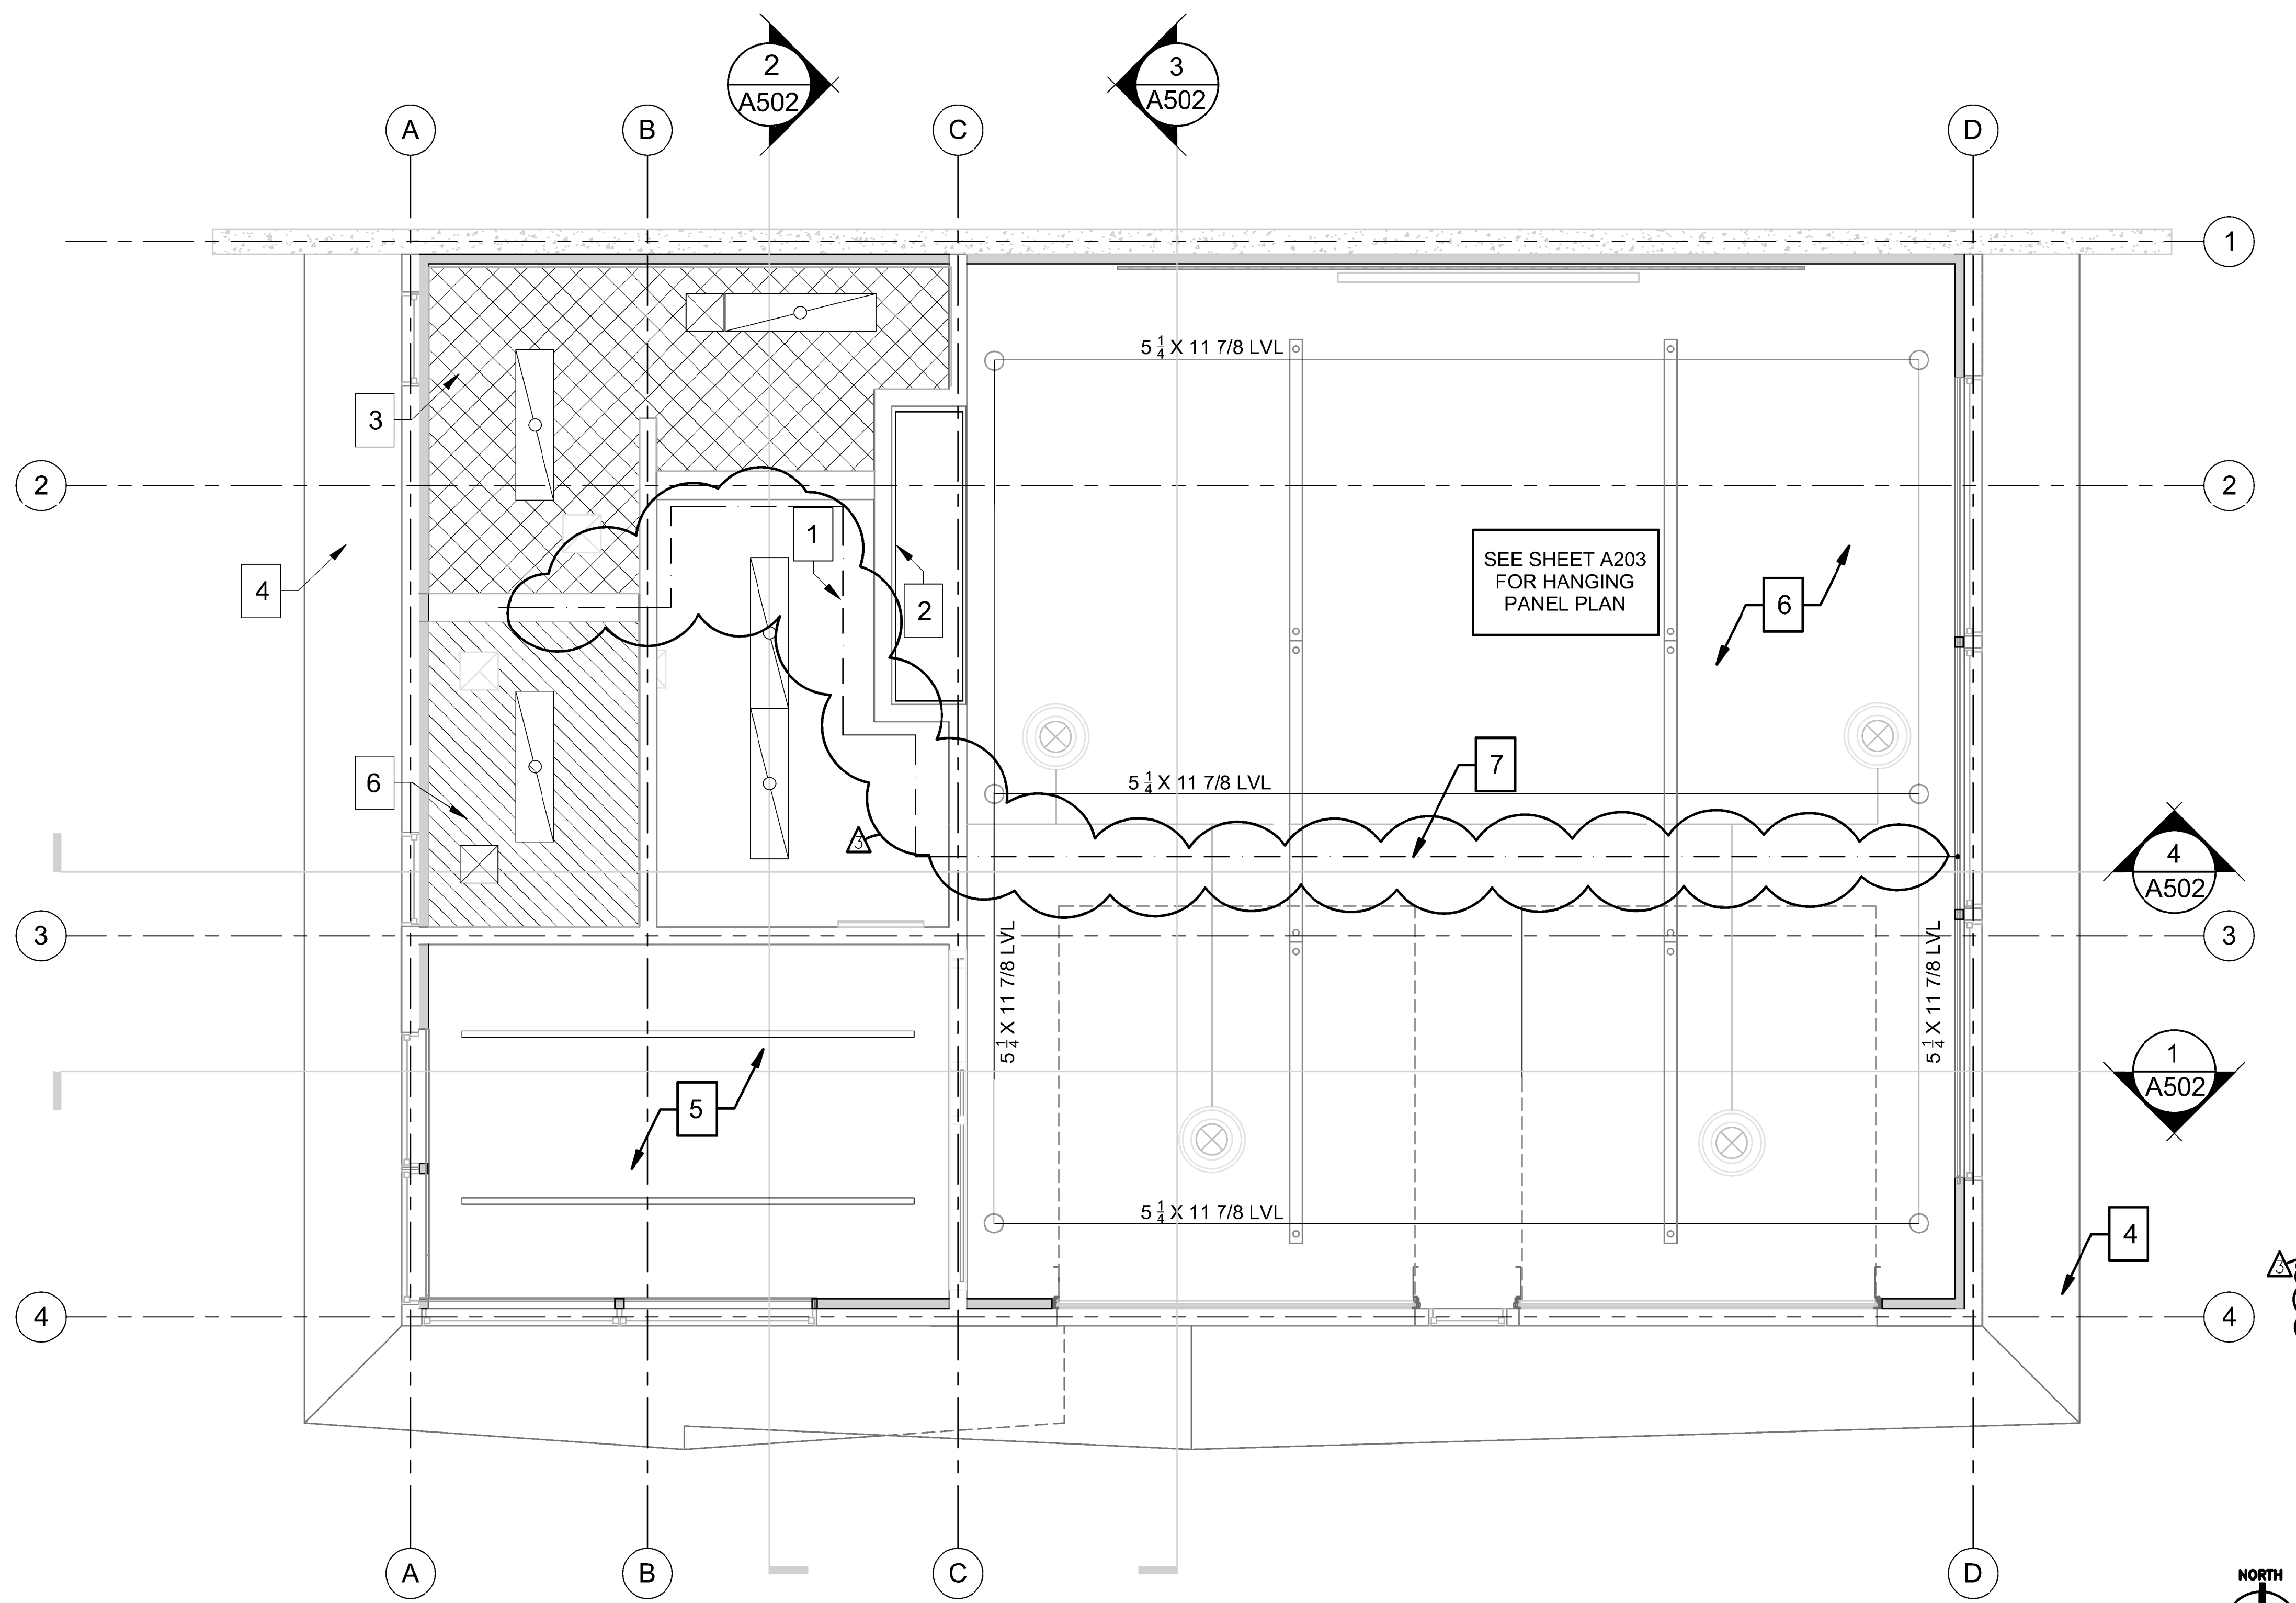

NEW REFLECTED CEILING PLAN
3/8" = 1'-0"